


(IN FEET) 1 inch = 10 ft.

1"=10'


SCALE: DATE: 11-10-16

PROJECT NO. 16-649 SHEET 1 OF 1 EXCAVATION NOTES: SECTIONS ON SHEET A12


MAIN HOUSE:		SDU:		PROJECT TOTALS:	
HOUSE CUT YARD CUT FOUNDATION CUT PIERS CUT TOTAL	= 108 CY = 42 CY = 38 CY = <u>76 CY</u> = 264 CY	HOUSE CUT YARD CUT FOUNDATION CUT PIERS CUT TOTAL	= 11 CY = 13 CY = 11 CY = <u>28 CY</u> = 63 CY	TOTAL CUT TOTAL FILL TOTAL FOR EXPORT	= 327 CY = <u>184 CY</u> = 143 CY
FILL	= 119 CY	FILL	= 65 CY		

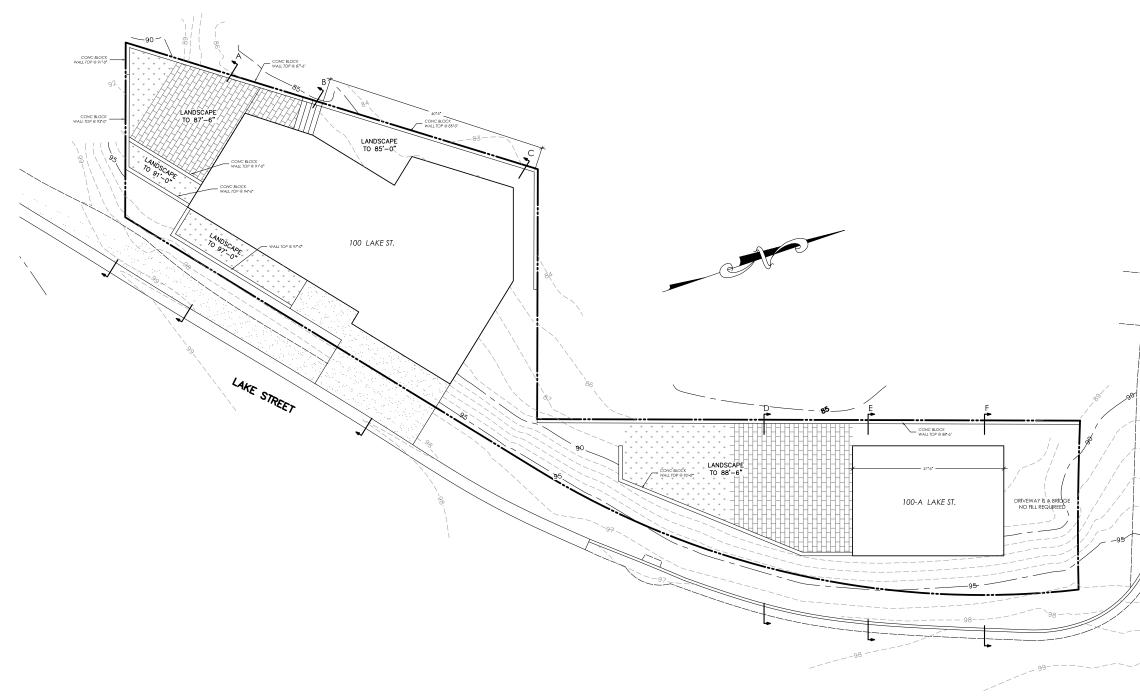

	Attach	ment 4	
	Allaun	^{ment} ₄ Kuhe	
		Desig	
		415–508–175 kuheldesign@sbcglobal.	
		GRADING PLAN	
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88		ZAMBRANO PROPERTY 100 - 100 A SAN BRUNO AVENL BRISBANE, CALIFORNIA	
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San Bruno		SNL NL	
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1		DRAWN BY: J. KUHE DATE: 8-15-17	:L
		REVISED:	
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		SCALE: 1/8" = 1'	
		JOB# 16-407	
		SHT A11 OF S	SHTS
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	Attach	Ment 4 Kuhel Design 415-508-1750 kuheldesign@sbcglobal.net
86 86 88 89 90 91 90 91 90 91 90 91 93 92 93 93 95 95 95 96 98 96 99 96 99 96 99 96 99 96 99 96 99 96		ZAMBRANO PROPERTY ZAMBRANO PROPERTY 100 - 100 A SAN BRUNO AVENUE BRISBANE, CALIFORNIA APPROVED: APPROVED: MARKANO PROPERTY SAMBRANO PROPERT
		SCALE: 1/8" = 1' JOB# 16-407 SHT A11.1 OF SHTS

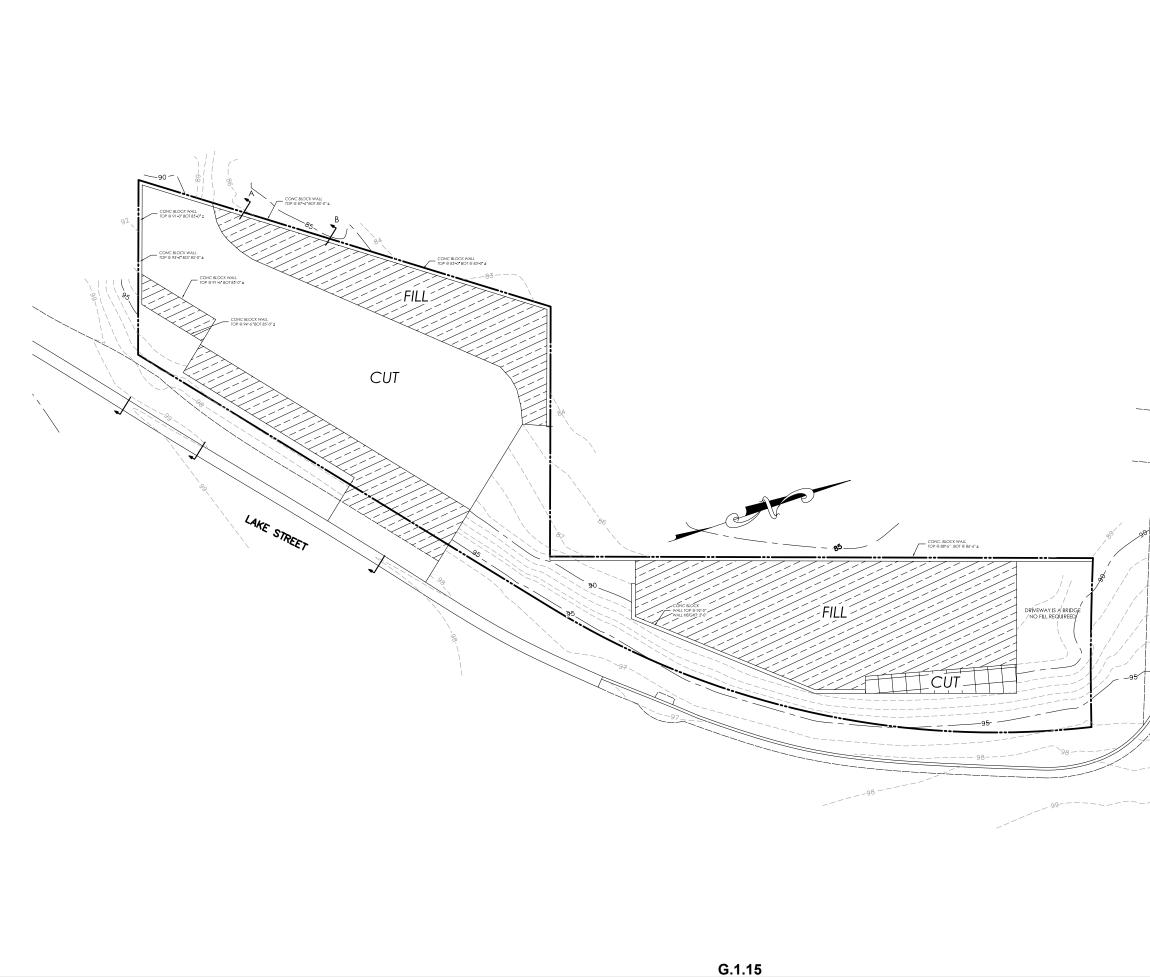

	Attach	^{ment} ₄ Kuhel
'ING, TH OF 1D	7. FOLLOWING PERIODS OF RAINFALL THE CONTRACTOR SHOULD CONTACT THE GEDTECHNICAL ENGINEER AND ARRANGE A WALKTHROUGH OF THE SITE IN ORDER TO VISUALLY ASSESS RAIN-RELATED DAMAGE. THE GEDTECHNICAL ENGINEER MAY ALSO RECOMMEND EXVATION AND TESTING IN ORDER TO AD IN THE ASSESSMENT. AT THE REQUEST OF THE GEDTECHNICAL ENGINEER THE CONTRACTOR SHALL MAKE EXCAVATIONS IN ORDER TO EVALUATE THE EXTEND OF RAIN-RELATED DAMAGE.	Design 415-508-1750
NS WHEN	8. RAIN-RELATED DAMAGE SHOULD BE CONSIDERED TO INCLUDE, BUT MAY NOT BE LIMITED TO, EROSION, SILTING, SATURATION, SONGHON, SILTING, SATURATION, SONGHON, SILTING, SATURATION, SILTING, SATURATION, ADVERSIY, AFFECTED SHOULD BE CLASSIFIED AS UNSUITED MATERIALS AND SHOULD BE SUBJECT TO OVEREXCANATION AND REPLACEMENT WITH COMPACTED FILL OR OTHER REMEIDAL GRADING AS RECOMMENDED BY THE GEOTECHNICAL ENGINEER.	kuheldesign@sbcglobal.net
ED AND ANT Y ED ALL CES CES CAIN.	9. RELATIVELY LEVEL AREAS, WHERE SATURATED SOIL AND/OR EROSION GULLIES EXIST TO DEPTHS OF GREATER THAN ONE FOOT, SHOULD BE OVEREXCAVATED TO UNAFFECTED, COMPETENT MATERIAL, WHERE LESS THAN ONE FOOT IN DEPTH, UNSUITABLE MATERIAL MAY BE PROCESSED IN PLACE TO ACHEEV REAR-OPTIMUM MOISTURE CONDITION, THEN THOROUGH! RECOMPACISION ACCORDANCE WITH THE APPLICABLE RECOMPACISION ACCORDANCE WITH THE APPLICABLE EVED. THE AFFECTED INATERIALS SHOULD BE OVEREXCAVATED THEN REPECTED MATERIALS SHOULD BE OVEREXCAVATED SHOULD BE OVEREXCAVATED AND REPLACED AS COMPACTED FILL IN ACCORDANCE WITH THE APPLICABLE SPECIFICATIONS, WHERE AFFECTED ANTERIALS SHOULD BE THOROUGH ST THOROUGH RE-COMPACITON IN ACCORDANCE WITH THESE GRADING BY MOISTURE CONDITIONS MOR PLACE, FOLLOWED BY THOROUGH RE-COMPACITON IN ACCORDANCE WITH THESE BEADING SPECIFICATIONS, MAY BE MALE, REMEDIAL GRADING BY MODES THE CONDITIONS DATE OVER EXAMINES AND A ACCORDANCE WITH THE AFFECTED MATERIALS SHOULD BE CONDRANCE WITH THE AFFECTED MATERIALS SHOULD BE SPECIFICATIONS, MAY BE RECOMMENDED BY THOROUGH RE-COMPACITON IN ACCORDANCE ON THE DESIRED RESULTS ARE NOT ACHEVED, ALL AFFECTED MATERIALS SHOULD BE CONDRANCE WITH THE AFFECTED MATERIALS SHOULD BE SPECIFICATIONS, MAY BE RECOMMENDED BY THOROUGH RECOMPACED WITH THE ADVERSE MAY BE RECOMMENDED BY THOROUGH RECOMPACES MAY BE RECOMMENDED BY THE CONTENTS ARE NOT ACHEVED DAMAGE SHOULD BE CONSERCE TO INCLUDE. BY THAY NOT BE LUMTED TO, EROSION, SLITING, SATURATION, HEREN, AS FIELD CONDITIONS DICTATE, OTHER SUCHERSE AND THERED DAMAGE SHOULD BE CONSERED TO INCLUDE. BUT MAY NOT BE LUMTED TO, EROSION, SLITING, SATU	GRADING SECTIONS
LL BE CTION S ACES. THE R DTS I ND ES, O R ND	CONDITIONS IDENTIFIED BY THE GEOTECHWICAL ENGINEER, SOL ADVERSLY, AFFECTED SHOULD BE CLASSIFIED AS UNSUITED MATERIALS AND SHOULD BE SUBJECT TO OVEREXCAVATION AND REPLACEMENT WITH COMMACTED FILL OR OTHER REVEICHAL GRADING AS RECOMMENDED BY THE GEOTECHMICAL ENGINEER. 9. RELATIVELY LVEL AREAS WHERE SATURATED SOL AND/OR EROSION GULLIES EXIST TO DEPTHS OF GREATER THAN ONE FOOT, SHOULD BE OVEREXCAVATED TO UNAFFECTED, COMPETENT MATERIAL WHERE LESS THAN ONE FOOT IN DEPTH, UNSUITABLE MATERIAL MAY BE PROCESSED IN PLACE TO ACHIEVE NEAR-OPTIMUM MOSTURE CONDITION, THEN THOROUGHLY RE-COMPACTED IN ACCORDANCE WITH THE APPLICABLE SPECIFICATIONS, IF THE DESIRED RESULTS ARE NOT ACHIEVED. THE AFFECTED IN ACCORDANCE WITH THE APPLICABLE SPECIFICATIONS, CHILLES EXIST TO DEPTHS OF GREATER THAN ONE FOOT, THEN REPLACED IN ACCORDANCE WITH THE APPLICABLE SPECIFICATIONS, U.D. IN SLOP ERASS, WHERE SATURATED SOL AND/OR EROSION GULLIES EXIST TO DEPTHS OF GREATER THAN ONE FOOT, THEY SHOULD BE OVEREXCAVATED TO AND REPLOCED AS COMPACTED FILL IN ACCORDANCE WITH THE APPLICABLE SPECIFICATIONS, SHOULD BE OVEREXCAVATED THEOL AND REPLOCED AS COMPACTED FILL IN ACCORDANCE WITH THE APPLICABLE SPECIFICATIONS, SHOULD BE OVEREXCAVATED THE AND REPLOCED AS COMPACTED FILL IN ACCORDANCE WITH THE APPLICABLE SPECIFICATIONS, SHOULD BE OVEREXCAVATED THEOL AND REPLOCED AS COMPACTED FILL IN ACCORDANCE WITH THE APPLICABLE SPECIFICATIONS, SHOULD BE OVEREXCAVATED TO DETHS OF ONE FOOT OF LESS BELOW PROPOSED PINSHED GRADE, REMEDIAL GRADING BY MOSTURE CONDITIONS IN A REAC, FOLLWED BY THOROUGH RE-COMPACTION IN ACCORDANCE WITH THESE GRADING SPECIFICATIONS, MAY BE TO DEPTHS OF ONE FOOT OF LESS BELOW PROPOSED PINSHED GRADE, REMEDIAL GRADING BY MOSTURE CONDITIONS MAY BE ACCOMPLICABLE SPECIFICATIONS, APPL REACHING AND REPLOCE DAS COMPACTED FILL ARE REACHING AND REPLOCE DAS COMPACTED FILL ARE REACHING AND REPLOCE REPAR REACTED FILL MACCOMPLICATIONS, MAY BE ACCOMPLICATIONS MAY BE ACCOMPLICATIONS HEREN, AS FIELD CONDITIONS DICTAE, OTHER SLOPE REPAR PROCEDURES MAY BE RECOMMENDED BY	
SE CT TO	ENGINEER CUT SLOPES 1. THE GEOTECHNICAL ENGINEER SHOULD REVIEW CUT SLOPES DURING EXCANATION. THE GEOTECHNICAL ENGINEER SHOULD BE NOTIFIED BY THE CONTRACTOR PRIOR TO BEGINING SLOPE EXCAVATIONS. 2. IF DURING THE COURSE OF GRADING, ADVERSE OR POTENTIALLY ADVERSE GEOTECHNICAL OR GEOLOCIC CONDITIONS ARE ENCOUNTERED WHICH WERE NOT ANTIOPATED IN THE PRELIMINARY REFORM THE GEOTE INVICAL RIGHTER OF THE ENCOUNTERED WHICH WERE NOT ANTIOPATED IN THE RECOMMENDATIONS TO TRACT THESE PROBLEMS. 3. WHEN CUT SLOPES ARE MADE IN THE CIRRECTION OF THE PREVAILING DRAINAGE, A NONERCOBLE DIVERSION SWALE (BROW DIFCH SHOULD BE PROVIDED AT THE TOP OF THE CUT	AVENUE
IN LD CT ITHE PF	PAD AREAS 1, PAD AREAS 1, PAD AREAS CREATED ABOVE CUT OR NATURAL SLOPES, POSITIVE DRAINAGE SHOULD BE ESTABLISHED AWAY FROM TOP-OF-SLOPE, THIS MAY BE ACCOMMENSIED BY UTILZING A BERN AND/OR AN APPROFRAITE PAD GRADEVIT. A GRADIENT IN SOL AREAS AWAY FROM THE TOP-OF-SLOPES OF 2 PERCENT OR GREATER IS RECOMMENDED; COMPACTED FILL 1.ALL FILL MATERIALS SHOULD BE COMPACTED AS SPECIFIED BELOW OR BY OTHER MEANS SPECIFICALLY RECOMMENDED BY THE GEOTISCHINGLE INCIDENT, UNLESS OTHERWISE SPECIFIED, THE MINIMUM DEGREE OF COMPACTION (RELATIVE COMPACITION) SHOULD BE GROW OF THE LABORATORY MAXIMUM BRY DEDRITY	NO PROPERTY A SAN BRUNO E, CALIFORNIA
SITE E	(MODIFIED PROCTOR). 2. UNDER PAD AREA THE CIVIL ENGINEER OR SURVEYOR SHALL CERTIFY THE ACTUAL PAD ELEVATION OR AS-BUILT CORNER ELEVATIONS. PLACEMENT	ZAMBRAI 100 - 100 BRISBANE Approved:
S EPT	I-DECEMENT I. PRIOR RO PLACEMENT OF COMPACTED FILL, THE CONTRACTOR SHOULD REQUEST A REVIEW BY THE GEOTECHNICAL ENGINEER OF THE EXPOSED GROUND SURFACE. JULIESS OTHERWISE RECOMMENDED, THE EXPOSED GROUND SURFACE SHOULD THEN BE SCARFIED (INCHES MIMMUM), WATER OF NOTED AS NEEDED, THOROUGHLY COMPACTED TO A MIMMUM OF 90 PERCENTOF THE MAXIMUM DRY DENSITY (MODIFIED PROCTOR)	DRAWN BY: J. KUHEL
NG E NG,	MAXIMUM DRY DENSITY (MODIFLED PROCIOR) 2. THE FILL SHOULD BE PLACED IN THIN HORIZONTAL LIFTS NOT EXCEEDING 8 INCHESAND COMPACTED TO THE DENSITY SPECIFIED. 3. EXCAVATED ON-SITE MATERIALS WHICH ARE ACCEPTABLE TO THE GEOTECHNICAL ENGINEER MAY BE UTILIZED AS COMPACTED FILL, PROVIDED TRASH, VEGETATION, AND OTHER DETETERIOUS MATERIALS ARE REMOVED PRIOR TO PLACEMENT.	DATE: 9-13-17 REVISED:
	4, ROCKS 12 INCHES IN MAXIMUM DIMENSION AND SMALLER MAY BE UTILIZED WITHIN THE COMPACTED FILL PROVIDED THEY ARE PLACED IN SUCH A MANARENTIAT INSTITUS OF THE ROCK IS ANOMES OR DRAINAGE GEOTEXTLES, FILL MATERIAL SHOULD BE FLACED AND THRONUGHLY COMPACTED OVER AND AROUND ALL ROCK, THE AMOUNT OF ROCK SHOULD NOT EXCEED 40 PERCENT BY DRY WEIGHT PASSING THE 2:: Set VE SIZE: THE "LINCH AND 40 PERCENT RECOMMENDATIONS HEREIN MAY VARY AS FIELD CONDITIONS DICTATE.	SCALE: AS NOTED JOB# 16-407 SHT A12 OF SHTS

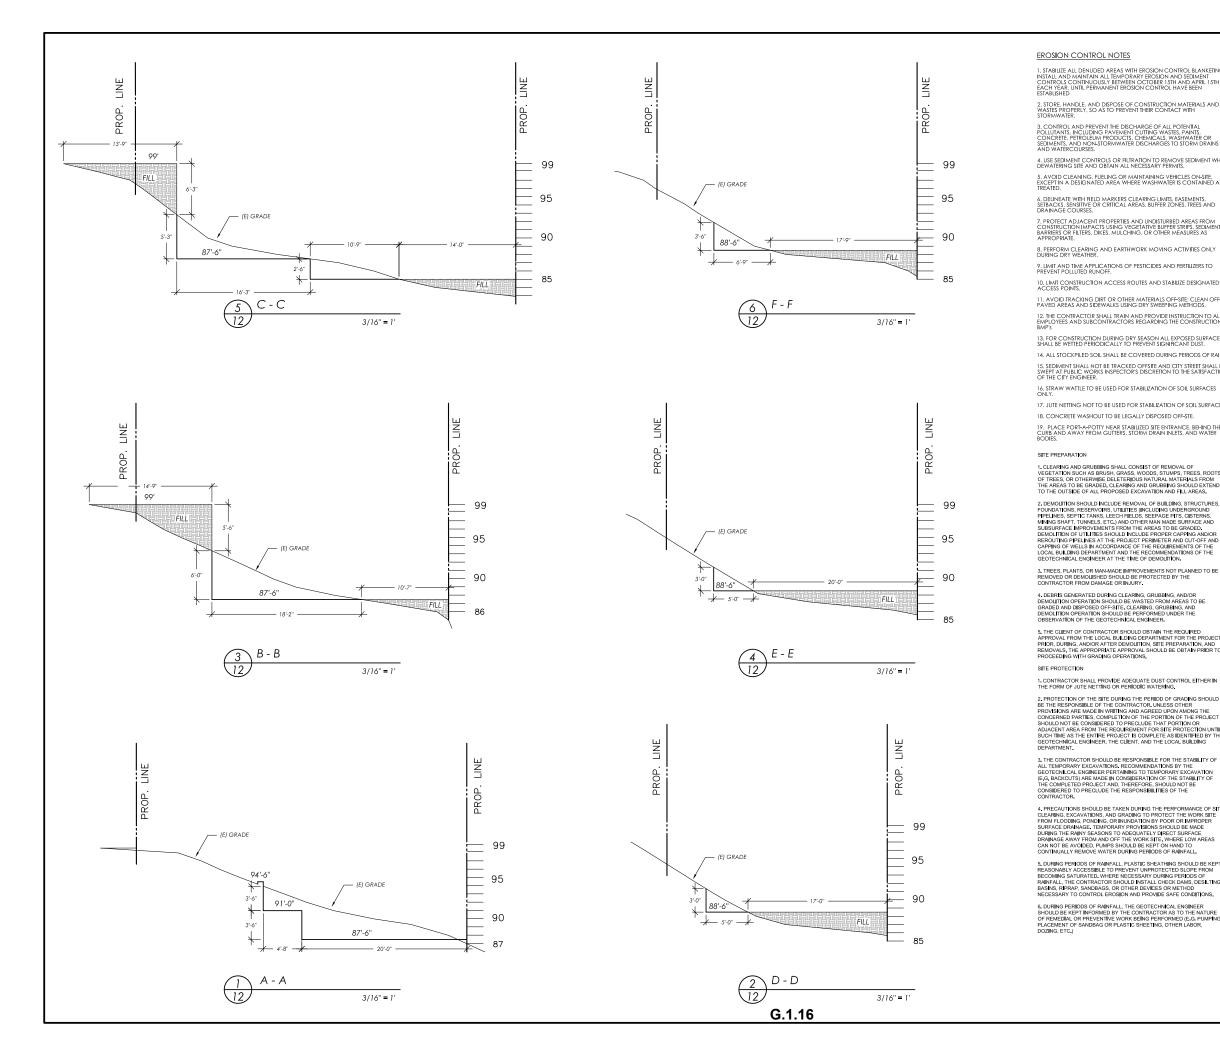